#### PROJECT INFORMATION

SCOPE OF WORK:

UNMANNED TELECOMMUNICATIONS FACILITY MODIFICATIONS

SITE ADDRESS:

27 COLLEGE AVENUE SOMERVILLE, MA 02144

LATITUDE: LONGITUDE: 42.39722° N

42° 23' 50" N -71.12138° W -71° 07' 17" W

JURISDICTION: CURRENT USE: NATIONAL, STATE & LOCAL CODES OR ORDINANCES TELECOMMUNICATIONS FACILITY

PROPOSED USE:

TELECOMMUNICATIONS FACILITY

800-638-2822




# **SITE NUMBER: MA2130** SITE NAME: SOMERVILLE CIAMPA MANOR

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FROM FRAMINGHAM, MA. START OUT GOING SOUTHWEST ON COCHITUATE RD/MA-30 W TOWARD WHITTIER ST. 0.2 MI MAKE A U-TURN ONTO COCHITUATE RD/MA-30 E. 0.3 MI MERGE ONTO I-90 E/MASS PIKE/MASSACHUSETTS TURNPIKE TOWARD 1-95/BOSTON (PORTIONS TOLL). 6.7 MI TAKE THE I-95 N/RT-128 N/RT-30 EXIT, EXIT 14, TOWARD N.H.-MAINE/POINTS NORTH. 1.2 MI MERGE ONTO 1-95 N/MA-128 N VIA THE EXIT ON THE LEFT TOWARD WALTHAM/PORTSMOUTH NH. 5.9 MI MERGE ONTO MA-2 E/CONCORD TURNPIKE VIA EXIT 29A TOWARD ARLINGTON/CAMBRIDGE. 6.4 MI TAKE THE US-3 N/RT-16 E EXIT ON THE LEFT TOWARD ARLINGTON/MEDFORD, 0.1 MI TURN SLIGHT LEFT ONTO US-3 N/MA-16 E/ALEWIFE BROOK PKWY. CONTINUE TO FOLLOW MA-16 E/ALEWIFE BROOK PKWY. 1.0 MI TURN RIGHT ONTO POWDER HOUSE BLVD. POWDER HOUSE BLVD. IS 0.1 MILES PAST BROADWAY 0.9 MI ENTER NEXT ROUNDABOUT AND TAKE 2ND EXIT ONTO COLLEGE AVE. 0.4 MI 27 COLLEGE AVE IS ON THE LEFT. YOUR DESTINATION IS JUST PAST

**VICINITY MAP** 

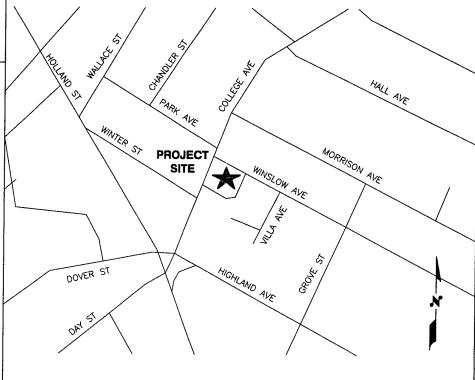

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DUPLICATION AND USE BY GOVERNMENT AGENCIES FOR THE PURPOSES OF CONDUCTING

THEIR LAWFULLY AUTHORIZED REGULATORY AND ADMINISTRATIVE FUNCTIONS IS SPECIFICALLY

**GENERAL NOTES** 

- 2. THE FACILITY IS AN UNMANNED PRIVATE AND SECURED EQUIPMENT INSTALLATION. IT IS ONLY ACCESSED BY TRAINED TECHNICIANS FOR PERIODIC ROUTINE MAINTENANCE AND THEREFORE DOES NOT REQUIRE ANY WATER OR SANITARY SEWER SERVICE. THE FACILITY IS NOT GOVERNED BY REGULATIONS REQUIRING PUBLIC ACCESS PER ADA REQUIREMENTS.
- CONTRACTOR SHALL VERIFY ALL PLANS AND EXISTING DIMENSIONS AND CONDITIONS ON THE JOB SITE AND SHALL IMMEDIATELY NOTIFY THE AT&T REPRESENTATIVE IN WRITING OF DISCREPANCIES BEFORE PROCEEDING WITH THE WORK OR BE RESPONSIBLE FOR SAME.




72 HOURS

BEFORE YOU DIG



CALL TOLL FREE 888-DIG-SAFE

UNDERGROUND SERVICE ALERT

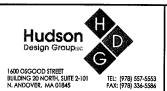



22 KEEWAYDIN DRIVE

SALEM, NH 03079

SITE NUMBER: MA2130 SITE NAME: SOMERVILLE **CIAMPA MANOR** 

27 COLLEGE AVENUE SOMERVILLE, MA 02144 MIDDLESEX COUNTY



550 COCHITUATE ROAD FRAMINGHAM, MA 01701

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AT&T TITLE SHEET 2130.01

#### **GROUNDING NOTES**

- 1. THE SUBCONTRACTOR SHALL REVIEW AND INSPECT THE EXISTING FACILITY GROUNDING SYSTEM AND LIGHTNING PROTECTION SYSTEM (AS DESIGNED AND INSTALLED) FOR STRICT COMPLIANCE WITH THE NEC (AS ADOPTED BY THE AHJ), THE SITE—SPECIFIC (UL, LPI, OR NFPA) LIGHTING PROTECTION CODE, AND GENERAL COMPLIANCE WITH TELCORDIA AND TIA GROUNDING STANDARDS. THE SUBCONTRACTOR SHALL REPORT ANY VIOLATIONS OR ADVERSE FINDINGS TO THE CONTRACTOR FOR RESOLUTION.
- 2. ALL GROUND ELECTRODE SYSTEMS (INCLUDING TELECOMMUNICATION, RADIO, LIGHTNING PROTECTION, AND AC POWER GES'S) SHALL BE BONDED TOGETHER, AT OR BELOW GRADE, BY TWO OR MORE COPPER BONDING CONDUCTORS IN ACCORDANCE WITH THE NEC.
- 3. THE SUBCONTRACTOR SHALL PERFORM IEEE FALL—OF—POTENTIAL RESISTANCE TO EARTH TESTING (PER IEEE 1100 AND 81) FOR NEW GROUND ELECTRODE SYSTEMS. THE SUBCONTRACTOR SHALL FURNISH AND INSTALL SUPPLEMENTAL GROUND ELECTRODES AS NEEDED TO ACHIEVE A TEST RESULT OF 5 OHMS OR LESS.
- 4. METAL RACEWAY SHALL NOT BE USED AS THE NEC
  REQUIRED EQUIPMENT GROUND CONDUCTOR. STRANDED
  COPPER CONDUCTORS WITH GREEN INSULATION, SIZED IN
  ACCORDANCE WITH THE NEC, SHALL BE FURNISHED AND
  INSTALLED WITH THE POWER CIRCUITS TO RTS FOLIPMENT
- EACH BTS CABINET FRAME SHALL BE DIRECTLY
   CONNECTED TO THE MASTER GROUND BAR WITH GREEN
   INSULATED SUPPLEMENTAL EQUIPMENT GROUND WIRES, 6
   AWG STRANDED COPPER OR LARGER FOR INDOOR BTS 2 AWG
   STRANDED COPPER FOR OUTDOOR BTS.
- 6. EXOTHERMIC WELDS SHALL BE USED FOR ALL GROUNDING CONNECTIONS BELOW GRADE.
- APPROVED ANTIOXIDANT COATINGS (I.E., CONDUCTIVE GEL OR PASTE) SHALL BE USED ON ALL COMPRESSION AND BOLTED GROUND CONNECTIONS.
- 8. ICE BRIDGE BONDING CONDUCTORS SHALL BE
  EXOTHERMICALLY BONDED OR BOLTED TO THE BRIDGE AND
  THE TOWER GROUND BAR.
- ALUMINUM CONDUCTOR OR COPPER CLAD STEEL CONDUCTOR SHALL NOT BE USED FOR GROUNDING CONNECTIONS.
- MISCELLANEOUS ELECTRICAL AND NON-ELECTRICAL METAL BOXES, FRAMES AND SUPPORTS SHALL BE BONDED TO THE GROUND RING, IN ACCORDANCE WITH THE NEC.
- 11. METAL CONDUIT SHALL BE MADE ELECTRICALLY
  CONTINUOUS WITH LISTED BONDING FITTINGS OR BY
  BONDING ACROSS THE DISCONTINUITY WITH 6 AWS COPPER
  WIRE UL APPROVED GROUNDING TYPE CONDUIT CLAMPS.
- 12. ALL NEW STRUCTURES WITH A FOUNDATION AND/OR FOOTING HAVING 20 FT. OR MORE 1/2" OR GREATER ELECTRICALLY CONDUCTIVE REINFORCING STEEL MUST HAVE IT BONDED TO THE GROUND RING USING AN EXOTHERMIC WELD CONNECTION USING #2 AWG SOLID TINNED COPPER GROUND WIRE, PER NEC 250.50

### **GENERAL NOTES**

1. FOR THE PURPOSE OF CONSTRUCTION DRAWING, THE FOLLOWING DEFINITIONS SHALL APPLY:

CONTRACTOR - SAI SUBCONTRACTOR - GENERAL CONTRACTOR (CONSTRUCTION) OWNER - AT&T MOBILITY

- 2. PRIOR TO THE SUBMISSION OF BIDS, THE BIDDING SUBCONTRACTOR SHALL VISIT THE CELL SITE TO FAMILIARIZE WITH THE EXISTING CONDITIONS AND TO CONFIRM THAT THE WORK CAN BE ACCOMPLISHED AS SHOWN ON THE CONSTRUCTION DRAWINGS. ANY DISCREPANCY FOUND SHALL BE BROUGHT TO THE ATTENTION OF CONTRACTOR.
- 3. ALL MATERIALS FURNISHED AND INSTALLED SHALL BE IN STRICT ACCORDANCE WITH ALL APPLICABLE CODES, REGULATIONS, AND ORDINANCES. SUBCONTRACTOR SHALL ISSUE ALL APPROPRIATE NOTICES AND COMPLY WITH ALL LAWS, ORDINANCES, RULES, REGULATIONS, AND LAWFUL ORDERS OF ANY PUBLIC AUTHORITY REGARDING THE PERFORMANCE OF THE WORK. ALL WORK CARRIED OUT SHALL COMPLY WITH ALL APPLICABLE MUNICIPAL AND UTILITY COMPANY SPECIFICATIONS AND LOCAL JURISDICTIONAL CODES, ORDINANCES AND APPLICABLE REGULATIONS.
- 4. DRAWINGS PROVIDED HERE ARE NOT TO BE SCALED AND ARE INTENDED TO SHOW OUTLINE ONLY.
- 5. UNLESS NOTED OTHERWISE, THE WORK SHALL INCLUDE FURNISHING MATERIALS, EQUIPMENT, APPURTENANCES, AND LABOR NECESSARY TO COMPLETE ALL INSTALLATIONS AS INDICATED ON THE DRAWINGS.
- 6. "KITTING LIST" SUPPLIED WITH THE BID PACKAGE IDENTIFIES ITEMS THAT WILL BE SUPPLIED BY CONTRACTOR. ITEMS NOT INCLUDED IN THE BILL OF MATERIALS AND KITTING LIST SHALL BE SUPPLIED BY THE SUBCONTRACTOR.
- 7. THE SUBCONTRACTOR SHALL INSTALL ALL EQUIPMENT AND MATERIALS IN ACCORDANCE WITH MANUFACTURER'S RECOMMENDATIONS UNLESS SPECIFICALLY STATED OTHERWISE.
- 8. IF THE SPECIFIED EQUIPMENT CANNOT BE INSTALLED AS SHOWN ON THESE DRAWINGS, THE SUBCONTRACTOR SHALL PROPOSE AN ALTERNATIVE INSTALLATION SPACE FOR APPROVAL BY THE CONTRACTOR.
- 9. SUBCONTRACTOR SHALL DETERMINE ACTUAL ROUTING OF CONDUIT, POWER AND T1 CABLES, GROUNDING CABLES AS SHOWN ON THE POWER, GROUNDING AND TELCO PLAN DRAWING. SUBCONTRACTOR SHALL UTILIZE EXISTING TRAYS AND/OR SHALL ADD NEW TRAYS AS NECESSARY. SUBCONTRACTOR SHALL CONFIRM THE ACTUAL ROUTING WITH THE CONTRACTOR.
- 10. THE SUBCONTRACTOR SHALL PROTECT EXISTING IMPROVEMENTS, PAVEMENTS, CURBS, LANDSCAPING AND STRUCTURES. ANY DAMAGED PART SHALL BE REPAIRED AT SUBCONTRACTOR'S EXPENSE TO THE SATISFACTION OF OWNER.
- 11. SUBCONTRACTOR SHALL LEGALLY AND PROPERLY DISPOSE OF ALL SCRAP MATERIALS SUCH AS COAXIAL CABLES AND OTHER ITEMS REMOVED FROM THE EXISTING FACILITY. ANTENNAS REMOVED SHALL BE RETURNED TO THE OWNER'S DESIGNATED LOCATION.
- 12. SUBCONTRACTOR SHALL LEAVE PREMISES IN CLEAN CONDITION.
- 13. ALL CONCRETE REPAIR WORK SHALL BE DONE IN ACCORDANCE WITH AMERICAN CONCRETE INSTITUTE (ACI) 301.
- 14. ANY NEW CONCRETE NEEDED FOR THE CONSTRUCTION SHALL BE AIR—ENTRAINED AND SHALL HAVE 4000 PSI STRENGTH AT 28 DAYS. ALL CONCRETE WORK SHALL BE DONE IN ACCORDANCE WITH ACI 318 CODE REQUIREMENTS.

- 15. ALL STRUCTURAL STEEL WORK SHALL BE DETAILED, FABRICATED AND ERECTED IN ACCORDANCE WITH AISC SPECIFICATIONS. ALL STRUCTURAL STEEL SHALL BE ASTM A36 (Fy = 36 ksi) UNLESS OTHERWISE NOTED. PIPES SHALL BE ASTM A53 TYPE E (Fy = 36 ksi). ALL STEEL EXPOSED TO WEATHER SHALL BE HOT DIPPED GALVANIZED. TOUCHUP ALL SCRATCHES AND OTHER MARKS IN THE FIELD AFTER STEEL IS ERECTED USING A COMPATIBLE ZINC RICH PAINT.
- 16. CONSTRUCTION SHALL COMPLY WITH UMTS SPECIFICATIONS AND "GENERAL CONSTRUCTION SERVICES FOR CONSTRUCTION OF AT&T MOBILITY SITES."
- 17. SUBCONTRACTOR SHALL VERIFY ALL EXISTING DIMENSIONS AND CONDITIONS PRIOR TO COMMENCING ANY WORK. ALL DIMENSIONS OF EXISTING CONSTRUCTION SHOWN ON THE DRAWINGS MUST BE VERIFIED. SUBCONTRACTOR SHALL NOTIFY THE CONTRACTOR OF ANY DISCREPANCIES PRIOR TO ORDERING MATERIAL OR PROCEEDING WITH CONSTRUCTION.
- 18. THE EXISTING CELL SITE IS IN FULL COMMERCIAL OPERATION. ANY CONSTRUCTION WORK BY SUBCONTRACTOR SHALL NOT DISRUPT THE EXISTING NORMAL OPERATION. ANY WORK ON EXISTING EQUIPMENT MUST BE COORDINATED WITH CONTRACTOR. ALSO, WORK SHOULD BE SCHEDULED FOR AN APPROPRIATE MAINTENANCE WINDOW USUALLY IN LOW TRAFFIC PERIODS AFTER MIDNIGHT.
- 19. SINCE THE CELL SITE IS ACTIVE, ALL SAFETY PRECAUTIONS MUST BE TAKEN WHEN WORKING AROUND HIGH LEVELS OF ELECTROMAGNETIC RADIATION. EQUIPMENT SHOULD BE SHUTDOWN PRIOR TO PERFORMING ANY WORK THAT COULD EXPOSE THE WORKERS TO DANGER. PERSONAL RF EXPOSURE MONITORS ARE ADVISED TO BE WORN TO ALERT OF ANY DANGEROUS EXPOSURE LEVELS.
- 20. APPLICABLE BUILDING CODES:
  SUBCONTRACTOR'S WORK SHALL COMPLY WITH ALL APPLICABLE NATIONAL,
  STATE, AND LOCAL CODES AS ADOPTED BY THE LOCAL AUTHORITY HAVING
  JURISDICTION (AHJ) FOR THE LOCATION. THE EDITION OF THE AHJ ADOPTED
  CODES AND STANDARDS IN EFFECT ON THE DATE OF CONTRACT AWARD
  SHALL GOVERN THE DESIGN.

BUILDING CODE: MA STATE BUILDING CODE 780 CMR 7TH EDITION ELECTRICAL CODE: REFER TO ELECTRICAL DRAWINGS LIGHTENING CODE: REFER TO ELECTRICAL DRAWINGS

 ${\tt SUBCONTRACTOR'S}$  work shall comply with the latest edition of the following standards:

AMERICAN CONCRETE INSTITUTE (ACI) 318; BUILDING CODE REQUIREMENTS FOR STRUCTURAL CONCRETE;

AMERICAN INSTITUTE OF STEEL CONSTRUCTION (AISC)

MANUAL OF STEEL CONSTRUCTION, ASD, NINTH EDITION;

TELECOMMUNICATIONS INDUSTRY ASSOCIATION (TIA) 222-F, STRUCTURAL STANDARDS FOR STEEL

ANTENNA TOWER AND ANTENNA SUPPORTING STRUCTURES; REFER TO ELECTRICAL DRAWINGS FOR SPECIFIC ELECTRICAL STANDARDS.

FOR ANY CONFLICTS BETWEEN SECTIONS OF LISTED CODES AND STANDARDS REGARDING MATERIAL, METHODS OF CONSTRUCTION, OR OTHER REQUIREMENTS, THE MOST RESTRICTIVE REQUIREMENT SHALL GOVERN. WHERE THERE IS CONFLICT BETWEEN A GENERAL REQUIREMENT AND A SPECIFIC REQUIREMENT, THE SPECIFIC REQUIREMENT SHALL GOVERN.

#### **ABBREVIATIONS** AGL ABOVE GRADE LEVEL GENERAL CONTRACTOR RADIO FREQUENCY G.C. RF AWG AMERICAN WIRE GAUGE MGB MASTER GROUND BUS **BCW** BARE COPPER WIRE MIN MINIMUM TBD TO BE DETERMINED BTS BASE TRANSCEIVER STATION TO BE REMOVED EXISTING EXISTING NOT TO SCALE TBRR TO BE REMOVED AND REPLACED FG FOLIPMENT GROUND REFERENCE TYP TYPICAL EQUIPMENT GROWND RING REQUIRED EGR

Hudson
Design Groupuc

1600 OSGOOD STREET
BUILDING 20 NORTH, SUITE 2-101
N, ANDOVER, MA 01845
FAX: (978) 335-5586



22 KEEWAYDIN DRIVE

SALEM, NH 03079

SITE NUMBER: MA2130 SITE NAME: SOMERVILLE CIAMPA MANOR

> 27 COLLEGE AVENUE SOMERVILLE, MA 02144 MIDDLESEX COUNTY



FRAMINGHAM, MA 01701


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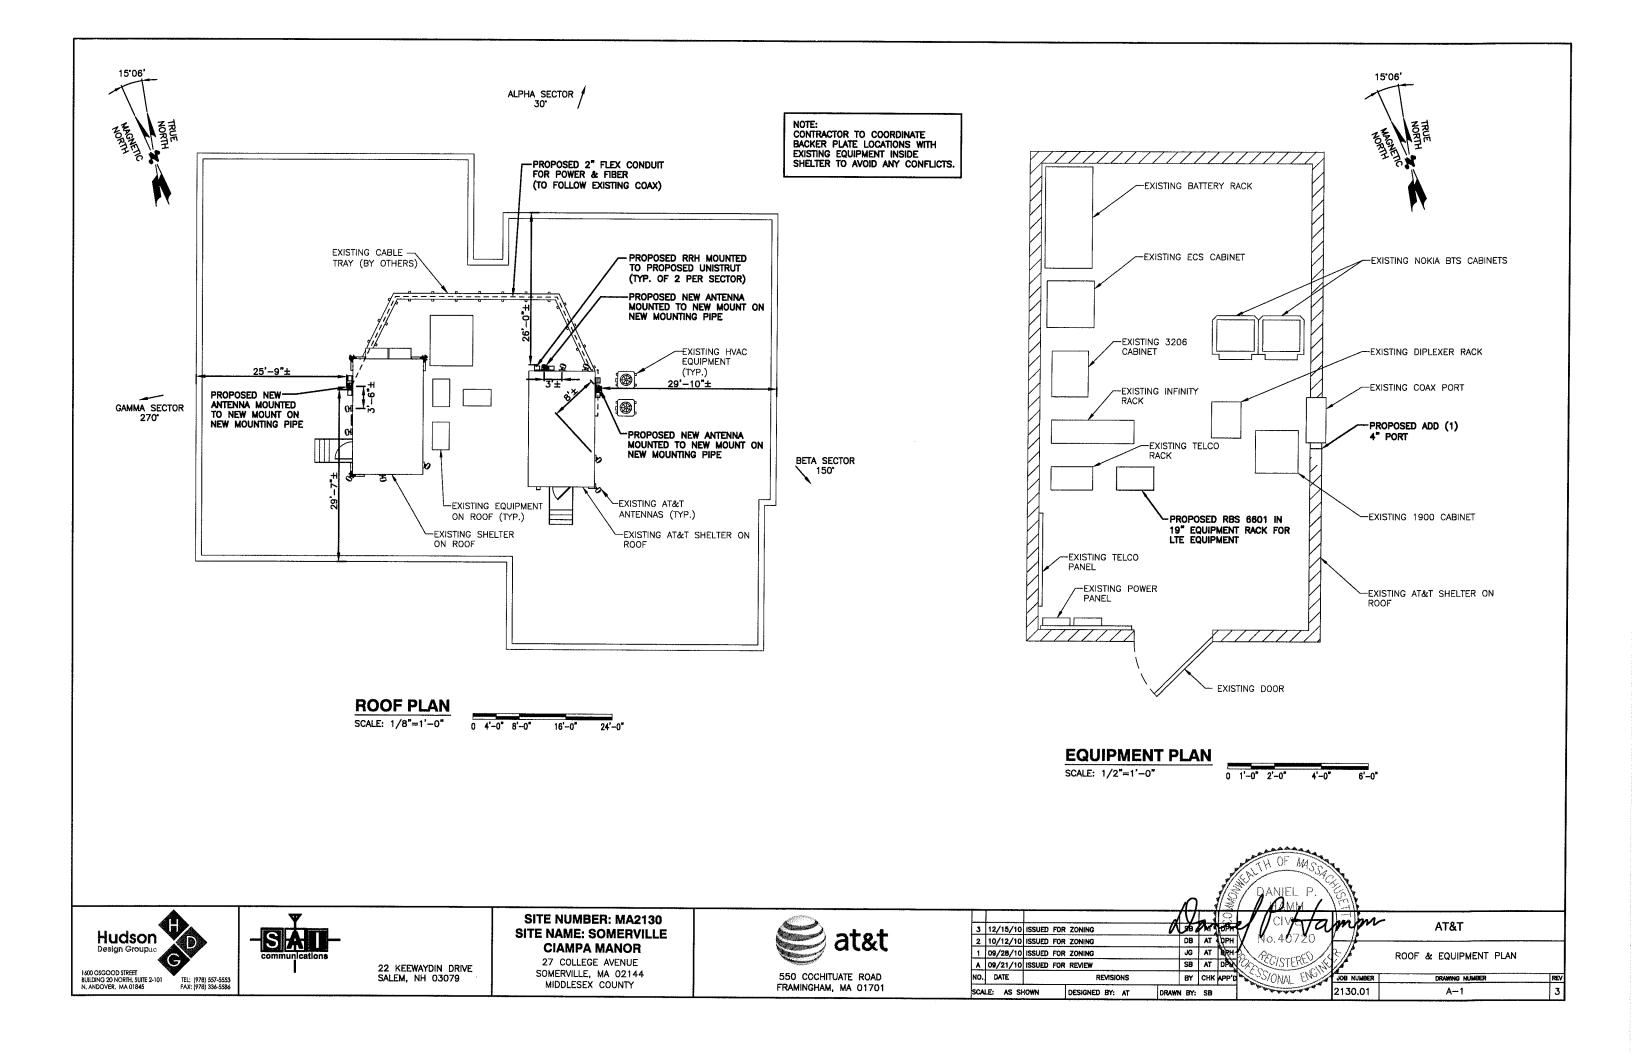
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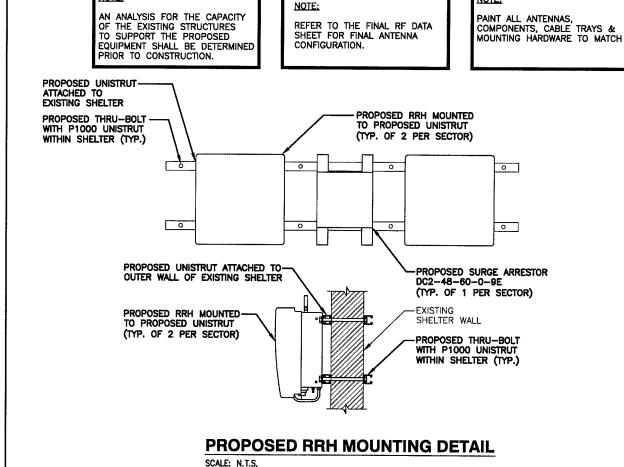
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GENERAL NOTES

WALL ENGINEER DRAWING NUMBER REV
2130.01 GN-1 3





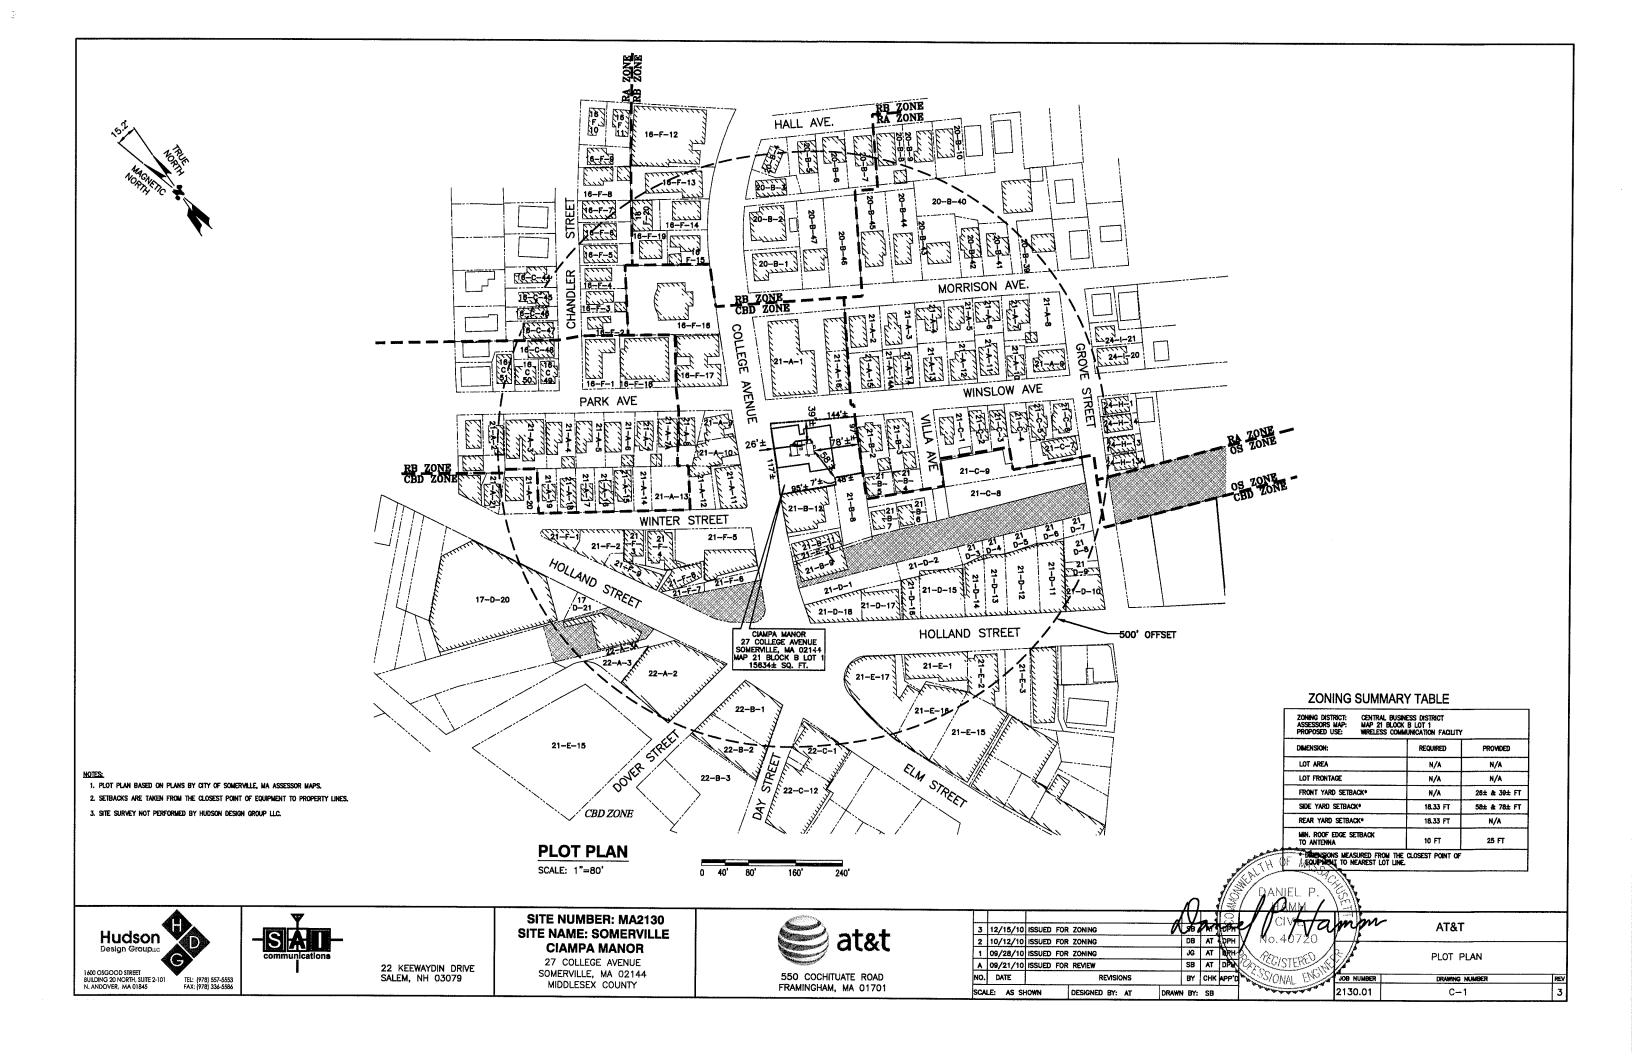

PROPOSED 2-3/8" ANTENNA SUPPORT PIPE PROPOSED ANTENNA DOWNTILT KIT PROPOSED 1 THRU-BOLT WITH P1000 UNISTRUT WITHIN SHELTER (TYP.)

EXISTING SHELTER WALL PROPOSED DUAL BAND ANTENNA (55.2"x11.8"x6.0") WALL MOUNT KIT FOR 2-3/8" PIPE MICROFLECT PART #B1592 OR

PRIME AND PAINT ALL MOUNTING BRACKETS AND ANTENNAS TO MATCH EXISTING SHELTER.

NOTE:

## PROPOSED ANTENNA DETAIL

22 KEEWAYDIN DRIVE

SALEM, NH 03079

SCALE: N.T.S.



NOTES:



**SITE NUMBER: MA2130** SITE NAME: SOMERVILLE **CIAMPA MANOR** 


APPROVED EQUAL


NOTE:

27 COLLEGE AVENUE SOMERVILLE, MA 02144 MIDDLESEX COUNTY





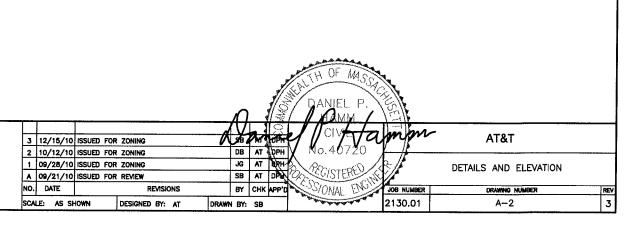


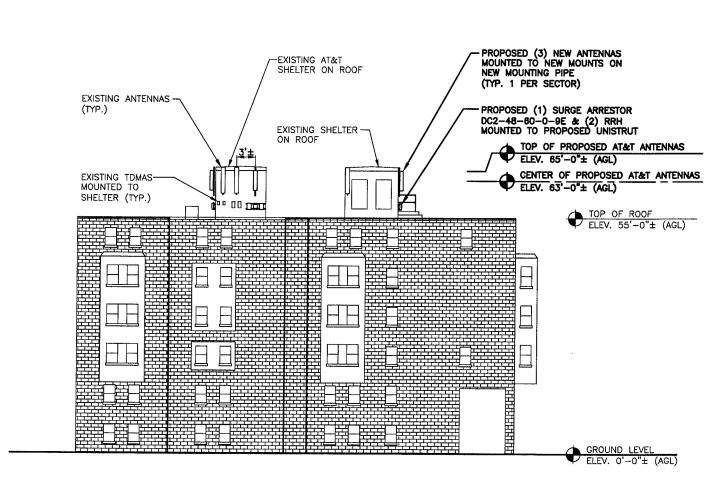


#### **NORTH ELEVATION**

SCALE: 3/32"=1'-0"




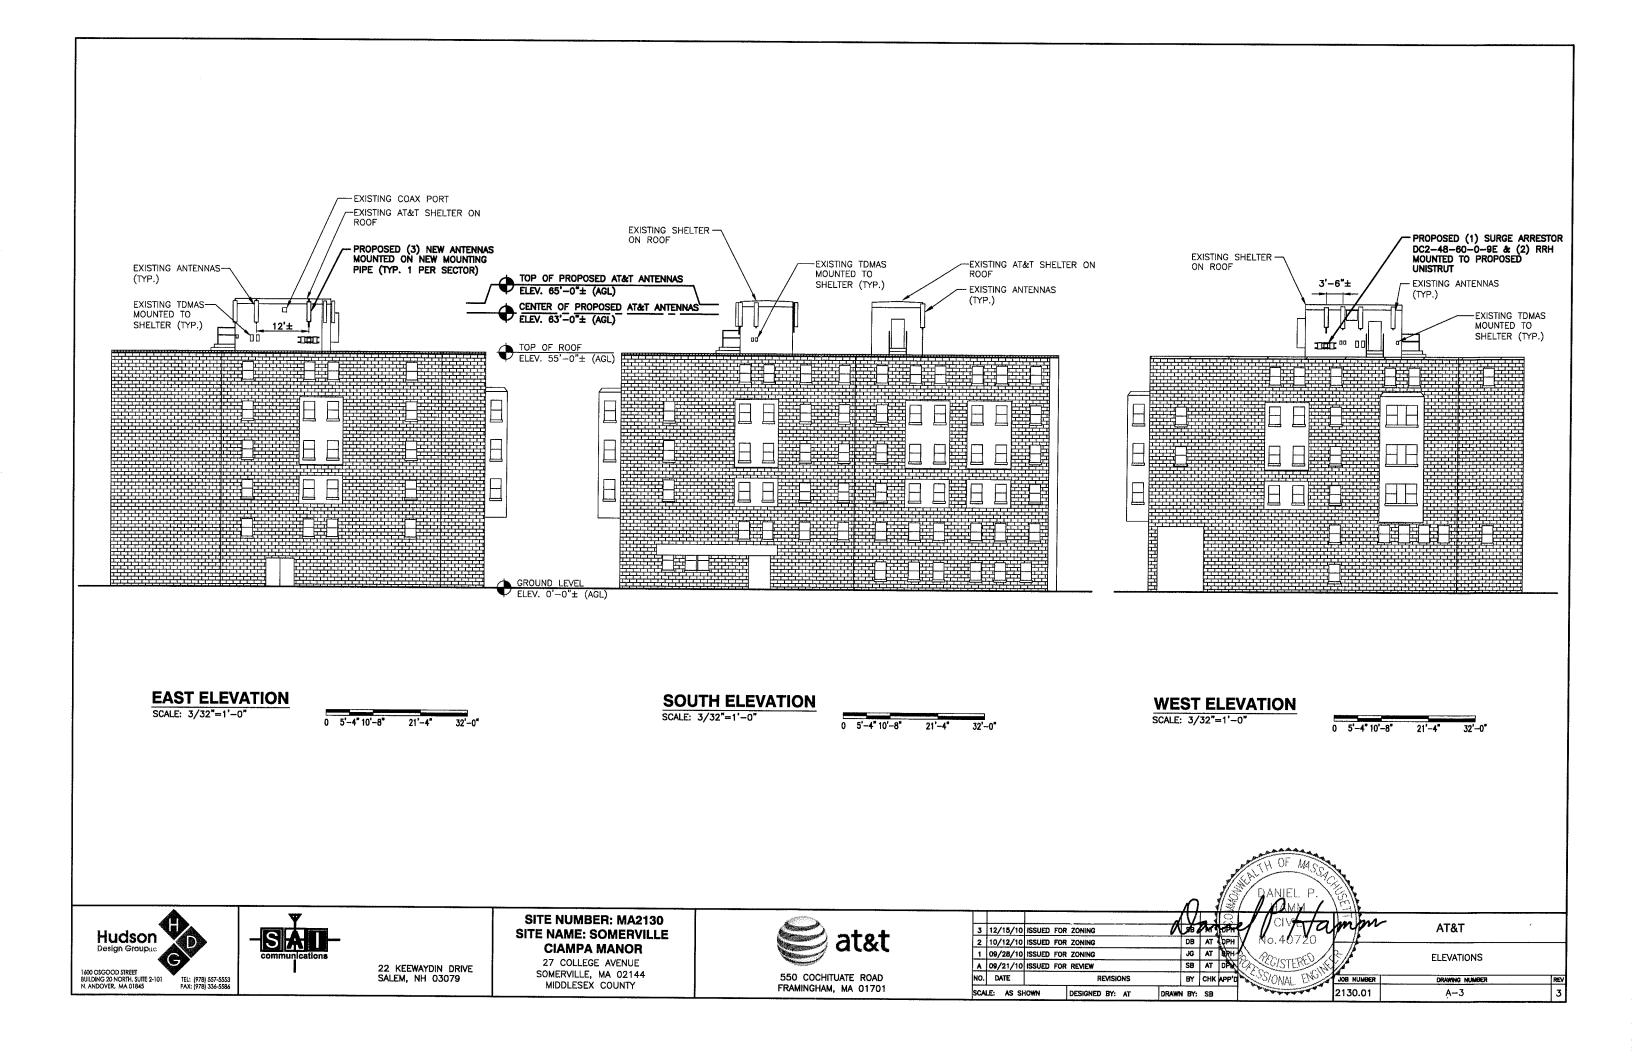

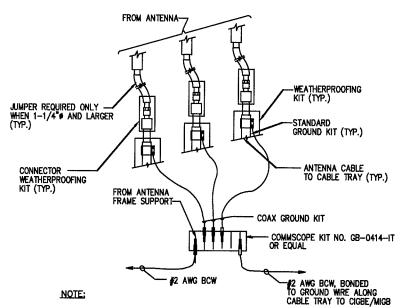

1. DO NOT INSTALL CABLE GROUND KIT AT A BEND AND ALWAYS DIRECT GROUND WIRE DOWN TO CIGBE.

#### **GROUND WIRE TO GROUND BAR CONNECTION DETAIL** N.T.S.

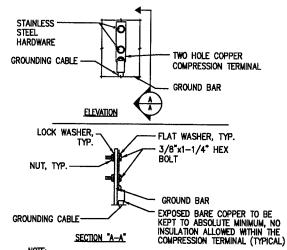


1. "DOUBLING UP" OR "STACKING" OF CONNECTION IS NOT PERMITTED. 2. OXIDE INHIBITING COMPOUND TO BE USED AT ALL LOCATIONS. 3. CADWELD DOWNLEADS FROM UPPER EGB, LOWER EGB, AND MGB.

### TYPICAL GROUND BAR **CONNECTION DETAIL**

N.T.S.

	WIRELESS SOLUTIONS INC.							
NO.	REQ.	PART NO.	DESCRIPTION					
①	1	HLGB-0420-IS	SOLID GND. BAR (20"x4"x1/4")					
2	2		WALL MTG. BRKT.					
3	2		INSULATORS					
<b>④</b>	4		5/8"-11x1" H.H.C.S.					
(5)	4		5/8 LOCKWASHER					

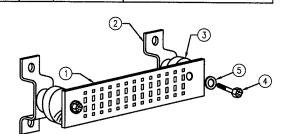


EACH GROUND CONDUCTOR TERMINATING ON ANY GROUND BAR SHALL HAVE AN IDENTIFICATION TAG ATTACHED AT EACH END THAT WILL IDENTIFY ITS ORIGIN AND DESTINATION.

SECTION "P" - SURGE PRODUCERS

CABLE ENTRY PORTS (HATCH PLATES) (#2) GENERATOR FRAMEWORK (IF AVAILABLE) (#2) TELCO GROUND BAR COMMERCIAL POWER COMMON NEUTRAL/GROUND BOND (#2) +24V POWER SUPPLY RETURN BAR (#2) -48V POWER SUPPLY RETURN BAR (#2) RECTIFIER FRAMES.


SECTION "A" - SURGE ABSORBERS

INTERIOR GROUND RING (#2) EXTERNAL EARTH GROUND FIELD (BURIED GROUND RING) (#2)
METALLIC COLD WATER PIPE (IF AVAILABLE) (#2) BUILDING STEEL (IF AVAILABLE) (#2)

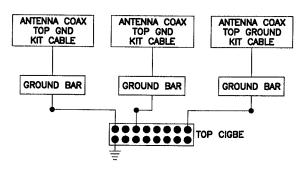

#### NOTES:


- 1. BOND ANTENNA GROUNDING KIT CABLE TO TOP CIGBE.
- 2. BOND ANTENNA GROUNDING KIT CABLE TO BOTTOM CIGBE.

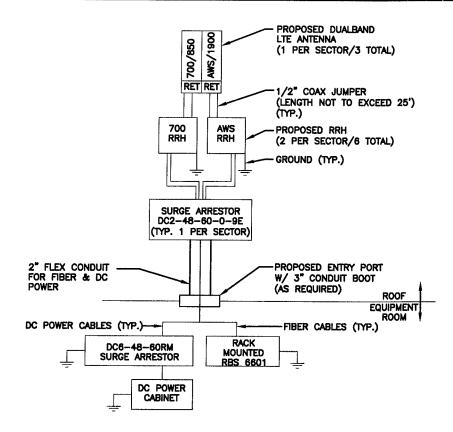

#### NOTES:

- 1. CONTRACTOR TO CONFIRM ALL PARTS.
- 2. INSTALL ALL EQUIPMENT TO MANUFACTURER'S RECOMMENDATIONS.



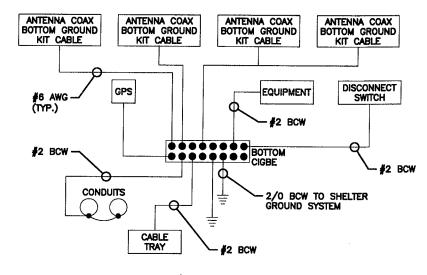


GROUND BAR - DETAIL

SITE NUMBER: MA2130 SITE NAME: SOMERVILLE **CIAMPA MANOR** 

27 COLLEGE AVENUE SOMERVILLE, MA 02144 MIDDLESEX COUNTY



550 COCHITUATE ROAD FRAMINGHAM, MA 01701

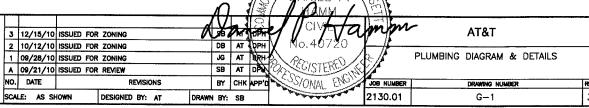

Hudson 1400 OSGOOD STREET BUILDING 20 NORTH, SUITE 2-101 N. ANDOVER, MA 01845

22 KEEWAYDIN DRIVE SALEM, NH 03079

SCHEMATIC GROUNDING DIAGRAM

## LOCUS MAP



PHOTO LOCATION

FOR VISUAL REFERENCE ONLY. ACTUAL VISABILITY IS DEPENDANT UPON WEATHER CONDITIONS, SEASON, SUNLIGHT, AND VIEWER LOCATION

APPROX. NORTH PHOTO LOCATIONS NOT TO SCALE

REV3: 11/22/10 REV2: 10/14/10 REV1: 10/01/10

SITE NO: MA2130 SITE NAME: SOMERVILLE CIAMPA MANOR 27 COLLEGE AVENUE SOMERVILLE, MA 02144 ADDRESS:



SITE TYPE: ROOFTOP

DATE: 09/09/10

DRAWN BY: DB

# EXISTING/PROPOSED CONDITIONS - EQUIPMENT NOT VISIBLE



## **PHOTO LOCATION #1** VIEW SOUTHEAST FROM PARK AVE./COLLEGE AVE. INTERSECTION

**DATE OF PHOTO: 09/03/10** 

REV3: 11/22/10

REV2: 10/14/10 REV1: 10/01/10

SITE NO:

MA2130 SITE NAME: SOMERVILLE CIAMPA MANOR

ADDRESS:

27 COLLEGE AVENUE SOMERVILLE, MA 02144



SITE TYPE: ROOFTOP

DATE: 09/09/10

DRAWN BY: DB

## **EXISTING CONDITIONS**



# PHOTO LOCATION # 2 VIEW NORTHEAST FROM WINTER AVE./COLLEGE AVE. DATE OF PHOTO: 09/03/10

REV3: 11/22/10 REV2: 10/14/10 REV1: 10/01/10

SITE NO: MA2130

SITE NAME: SOMERVILLE CIAMPA MANOR

ADDRESS: 27 COLLEGE AVENUE SOMERVILLE, MA 02144



SITE TYPE: ROOFTOP

DATE: 09/09/10

DRAWN BY: DB

## PROPOSED CONDITIONS



PROPOSED (3) NEW ANTENNAS MOUNTED TO NEW MOUNTS ON NEW MOUNTING PIPE (TYP. 1 PER SECTOR)



## PHOTO LOCATION # 2 VIEW NORTHEAST FROM WINTER AVE./COLLEGE AVE. **DATE OF PHOTO: 09/03/10**

REV3: 11/22/10 REV2: 10/14/10

REV1: 10/01/10

SITE NO: MA2130

SITE NAME: SOMERVILLE CIAMPA MANOR

**ADDRESS**: 27 COLLEGE AVENUE SOMERVILLE, MA 02144



SITE TYPE: ROOFTOP

DATE: 09/09/10

550 COCHITUATE ROAD FRAMINGHAM, MA 01701

DRAWN BY: DB

## **EXISTING CONDITIONS**



# PHOTO LOCATION # 3 VIEW WEST FROM WINSLOW AVE./VILLA AVE, INTERSECTION DATE OF PHOTO: 09/03/10

REV3: 11/22/10 REV2: 10/14/10

REV1: 10/01/10

SITE NO: MA2130

SITE NAME: SOMERVILLE CIAMPA MANOR

ADDRESS: 27 COLLEGE AVENUE SOMERVILLE, MA 02144




SITE TYPE: ROOFTOP

DATE: 09/09/10

DRAWN BY: DB

## PROPOSED CONDITIONS

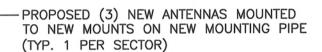



## PHOTO LOCATION #3 VIEW WEST FROM WINSLOW AVE./VILLA AVE, INTERSECTION **DATE OF PHOTO: 09/03/10**

REV3: 11/22/10 REV2: 10/14/10

REV1: 10/01/10

SITE NO: MA2130

SITE NAME: SOMERVILLE CIAMPA MANOR

27 COLLEGE AVENUE SOMERVILLE, MA 02144 ADDRESS:



SITE TYPE: ROOFTOP

DATE: 09/09/10

DRAWN BY: DB

## **EXISTING CONDITIONS**



# PHOTO LOCATION # 4 VIEW SOUTH FROM MORRISON AVE. DATE OF PHOTO: 09/03/10

REV3: 11/22/10 REV2: 10/14/10

REV1: 10/01/10

SITE NO: MA2130

SITE NAME: SOMERVILLE CIAMPA MANOR

ADDRESS: 27 COLLEGE AVENUE SOMERVILLE, MA 02144




SITE TYPE: ROOFTOP

DATE: 09/09/10

DRAWN BY: DB

### PROPOSED CONDITIONS

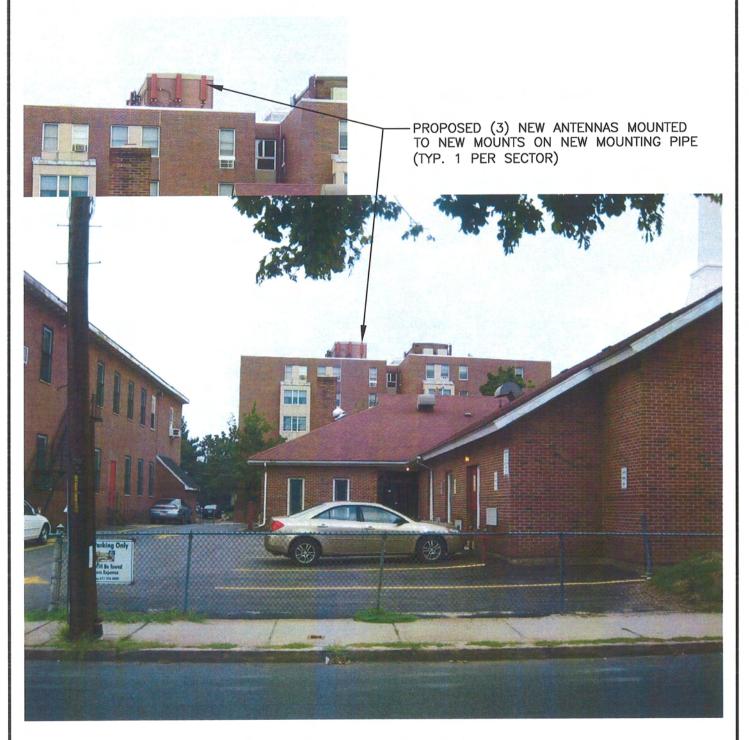

## PHOTO LOCATION # 4 VIEW SOUTH FROM MORRISON AVE. **DATE OF PHOTO: 09/03/10**

REV3: 11/22/10 REV2: 10/14/10 REV1: 10/01/10

SITE NO:

MA2130

SITE NAME: SOMERVILLE CIAMPA MANOR

ADDRESS:

27 COLLEGE AVENUE SOMERVILLE, MA 02144



550 COCHITUATE ROAD FRAMINGHAM, MA 01701

SITE TYPE: ROOFTOP

DATE: 09/09/10

DRAWN BY: DB